




Cad Ref. : WSD023401-C.dwg

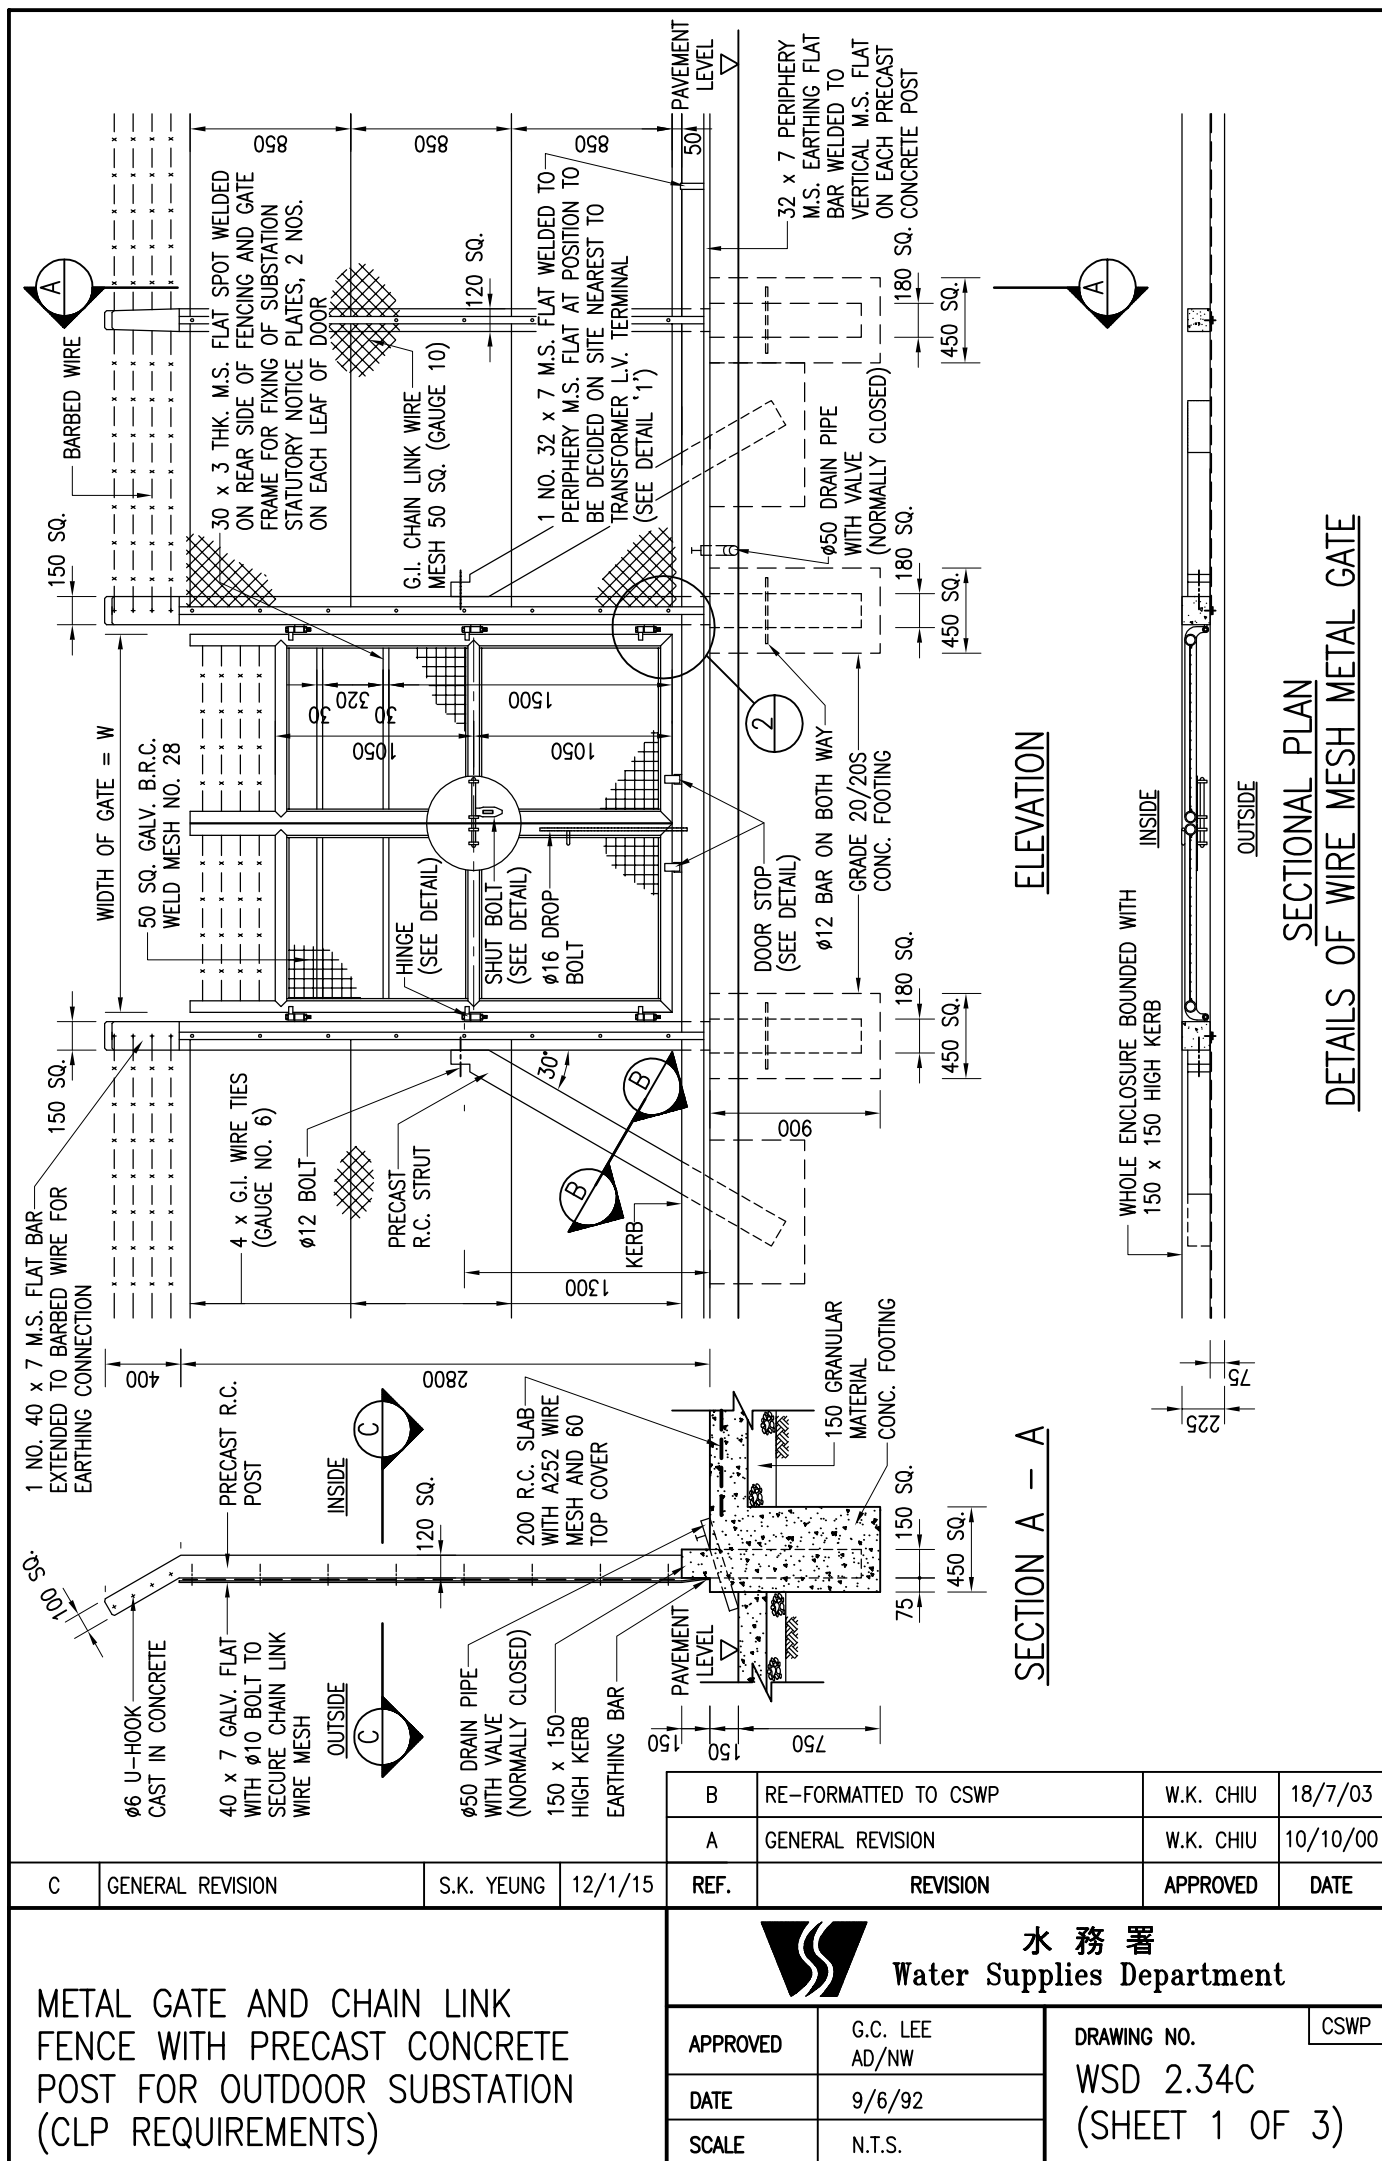


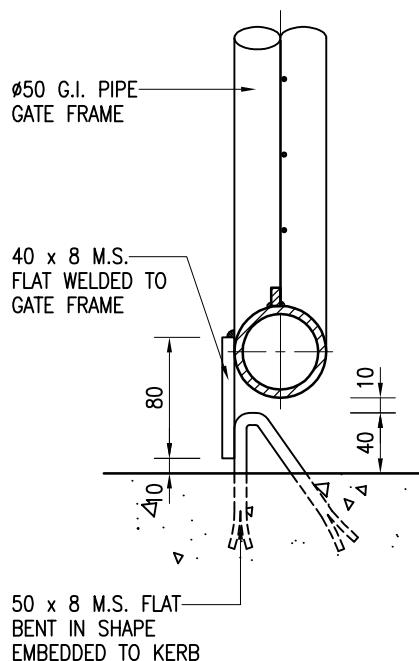


DETAILS OF DOOR STOP

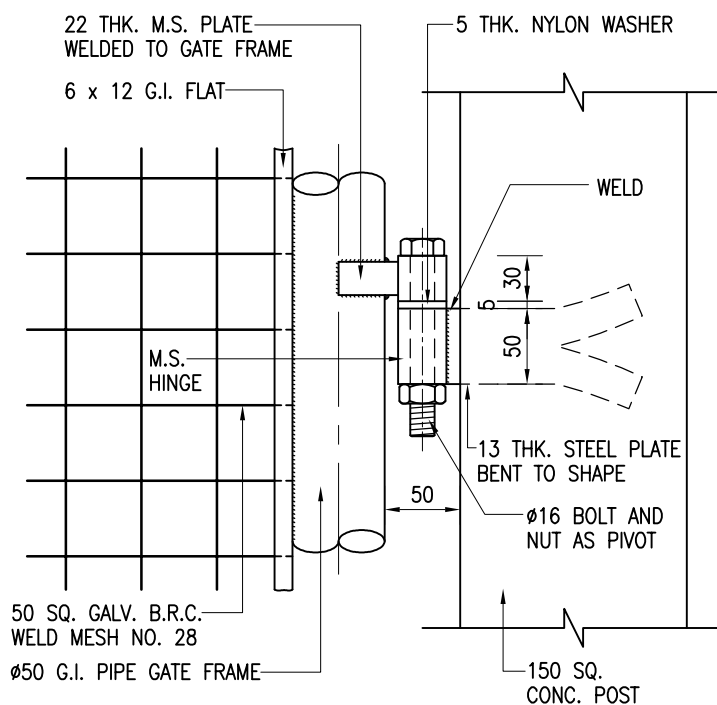


ELEVATION

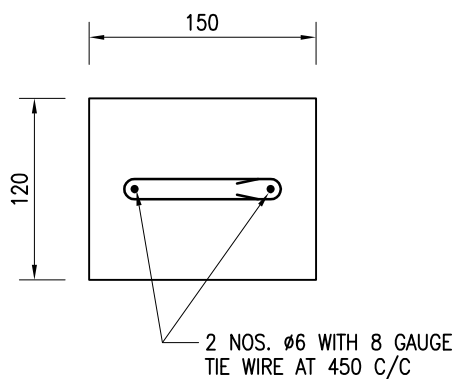


SECTION B - B

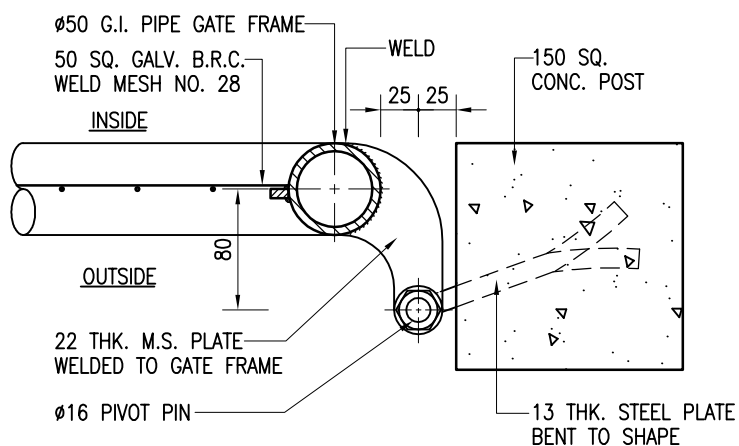

PLAN  
DETAILS OF HINGE

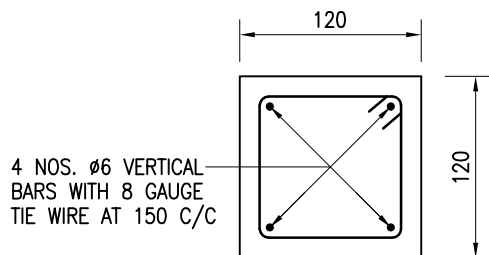

SECTION C - C

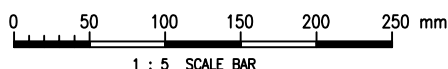

Cad Ref. : WSD023402-C.dwg

METAL GATE AND CHAIN LINK FENCE WITH PRECAST CONCRETE POST FOR OUTDOOR SUBSTATION (CLP REQUIREMENTS)



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Water Supplies Department

APPROVED

G.C. LEE  
AD/NW

DATE

9/6/92

SCALE


1 : 5

DRAWING NO.


WSD 2.34C

(SHEET 2 OF 3)


CSWP

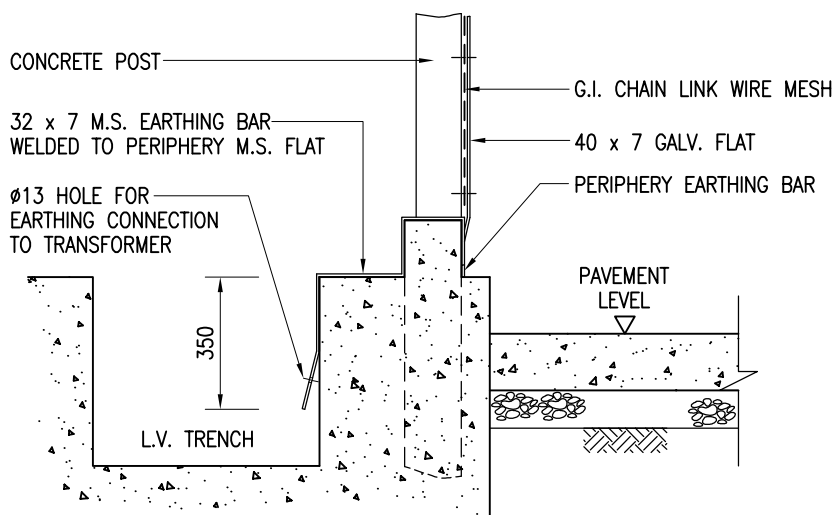


DETAIL '1'  
SCALE 1 : 20

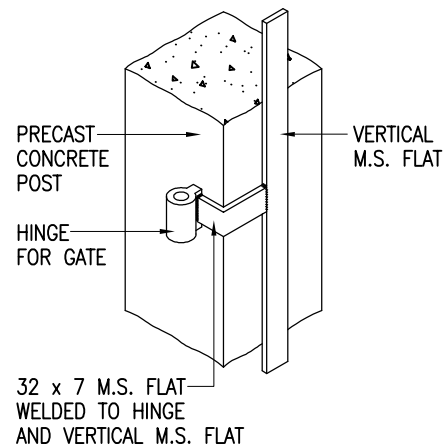

DETAIL '2'  
N.T.S.

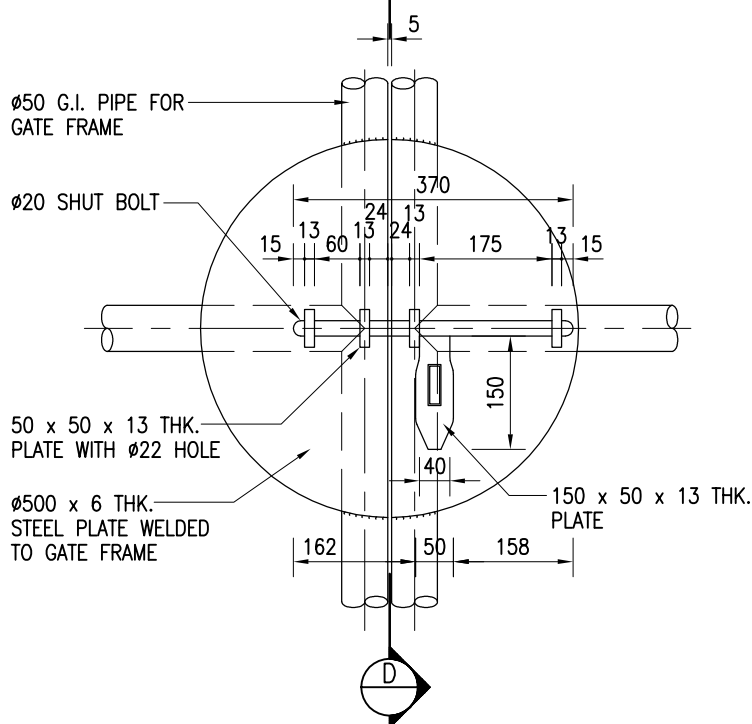

FRONT ELEVATION

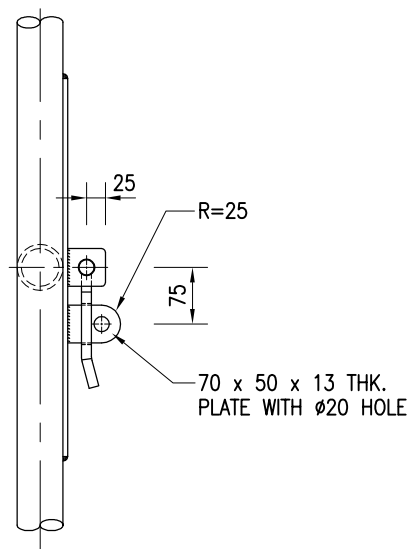


SECTION D - D

NOTES :


### DETAILS OF SHUT BOLT

SCALE 1 : 10

1. ALL DIMENSIONS ARE IN MILLIMETRES.
2. ALL STEELWORKS SHALL BE HOT-DIP GALVANIZED TO BS EN ISO 1461 AND FINISHED WITH ONE COAT OF CALCIUM PLUMBATE PRIMER AND TWO FINISHING COATS OF SYNTHETIC PAINT.
3. PRECAST R.C. STRUT SHALL BE PROVIDED TO THE END OR CORNER POSTS.
4. PRECAST POSTS AND STRUTS SHALL BE OF GRADE 30/10S CONCRETE.
5. DIMENSION W SHALL BE AS SHOWN ON THE CONTRACT DRAWINGS.

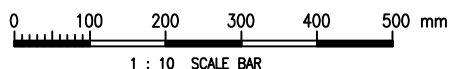

1 : 10 SCALE BAR

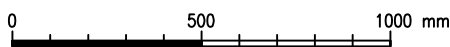

1 : 20 SCALE BAR

Cad Ref. : WSD023403-C.dwg

METAL GATE AND CHAIN LINK  
FENCE WITH PRECAST CONCRETE  
POST FOR OUTDOOR SUBSTATION  
(CLP REQUIREMENTS)



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Water Supplies Department

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AD/NW

DATE

9/6/92

SCALE

1 : 20 OR AS SHOWN

DRAWING NO.

WSD 2.34C

(SHEET 3 OF 3)

CSWP